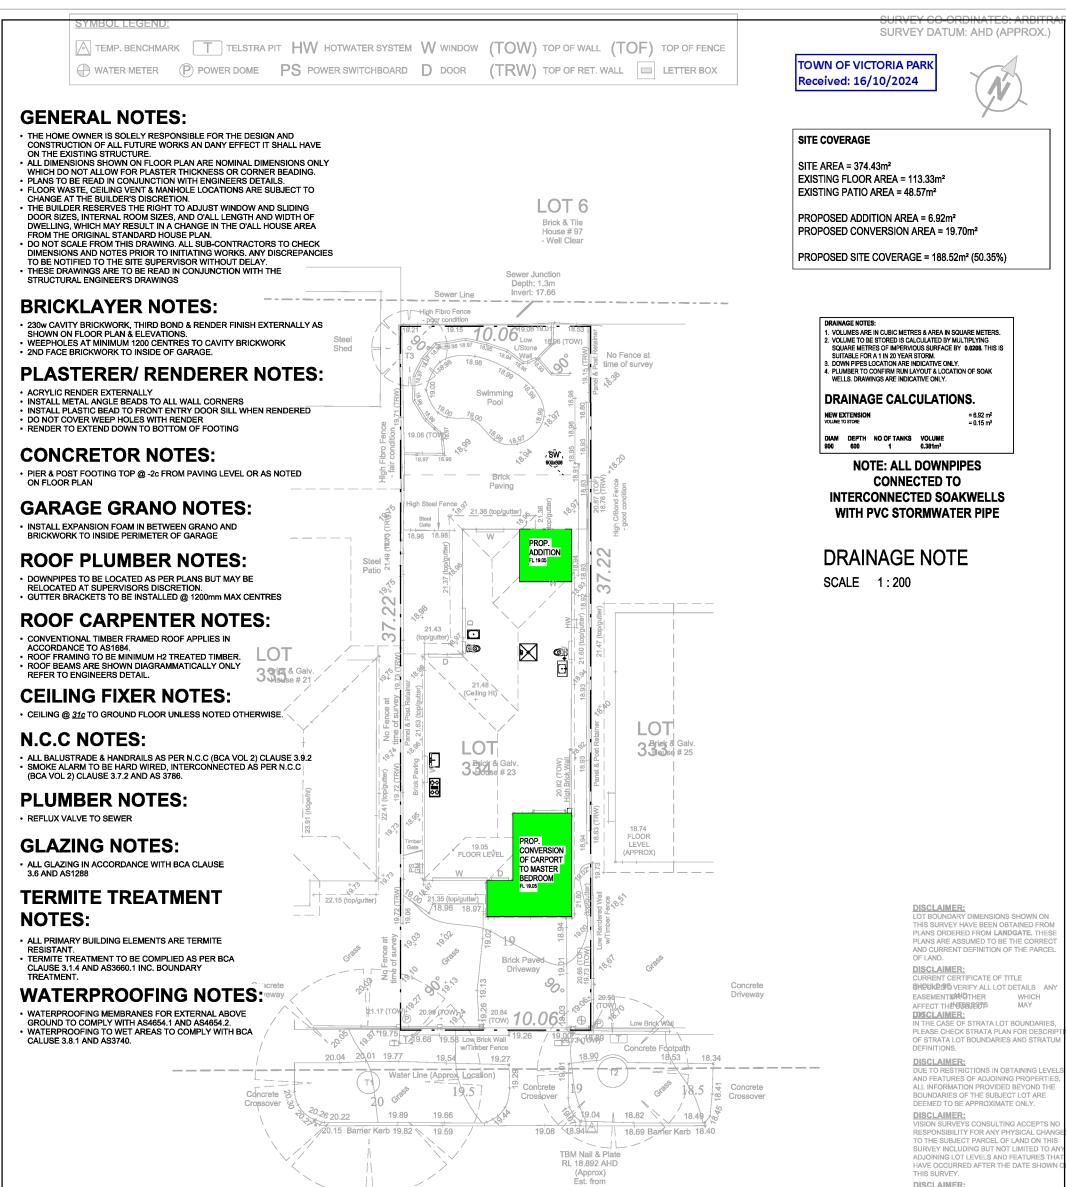
### TOWN OF VICTORIA PARK Received: 16/10/2024

# ARCHITECTURAL DRAWING LIST

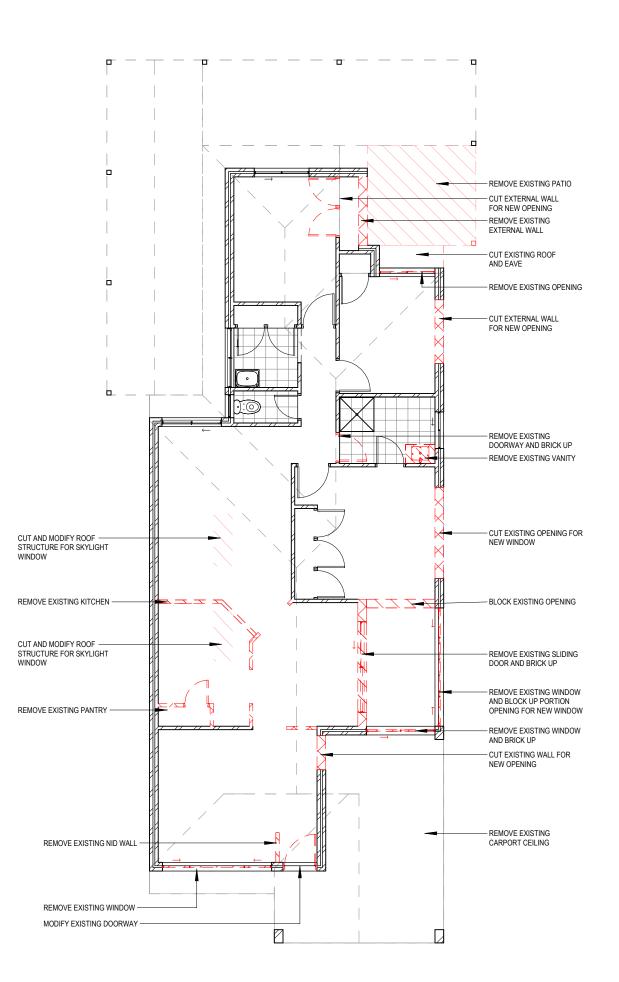
AD01 SITE PLAN 2024-10-1			
AD01 SITE PLAN 2024-10-1	Sheet	Name	Date
	AD00	COVER PAGE	2024-10-16
AD02 DEMOLITION PLAN 2024-10-1	AD01	SITE PLAN	2024-10-16
	AD02	DEMOLITION PLAN	2024-10-16
AD03 PROPOSED FLOOR PLAN 2024-10-1	AD03	PROPOSED FLOOR PLAN	2024-10-16
AD04 ELEVATIONS 2024-10-1	AD04	ELEVATIONS	2024-10-16
AD05 ROOF PLAN 2024-10-1	AD05	ROOF PLAN	2024-10-16
AD06 SECTIONS & DETAILS 2024-10-1	AD06	SECTIONS & DETAILS	2024-10-16
AD07 WET AREAS 2024-10-1	AD07	WET AREAS	2024-10-16
AD08 ELECTRICAL PLAN 2024-10-1	AD08	ELECTRICAL PLAN	2024-10-16

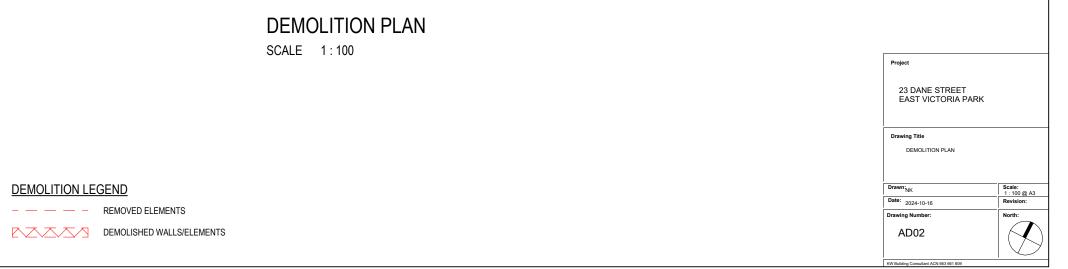


			Project	
			23 DANE STREET EAST VICTORIA PA	ARK
			Drawing Title	
			COVER PAGE	
			Drawn: <sub>NK</sub>	Scale: @ A3
			Date: 2024-10-16	Revision:
			Drawing Number:	North:
			AD00	
			KW Building Consultant ACN 663 661 809	I



								THIS SURVEY ONLY SHOWS SITE FE WHICH ARE VISIBLE AND ACCESSIBL	
:	20.63	19.84 Road Centre	Line		18.55			TIME OF SURVEY. THE POSITION OF UNDERGROUND SERVICES SHOULD PRIOR TO FINALISATION OF ANY DES	ANY BE VERIFE
		DANE	STREET	Tree	ID Trunk Canop 1.20 12.0	y Tree Height 8.0	Comment 1.3 DBH	DISCLAIMER: THIS SURVEY DOES NOT VERIFY THI OF CADASTRAL BOUNDARIES. ALL F ARE BASED ON THE ORIENTATION O PEGS, FENCES, AND WILLS WHICH I ON THE CORRECT ALIGNMENT. A CA ALIGNMENT SURVEY SHOULD BE UN TO VERIFY TRUE BOUNDARY POSITI ADOPTING ANY SITE FEATURES FOR PURPOSES. DISCLAIMER:	EATURES DF EXISTING MAY NOT B ADASTRAL NDERTAKEN IONS BEFOR
				T2	2 1.60 12.0	8.0	1.7 DBH	AHD HEIGHT IS APPROXIMATE AND H DERIVED FROM EITHER NETWORK G	
				T3	0.20 4.0	4.0		NEARBY WATERCORP. ASSET. REFE	ER TO THE
								TBM REFERENCE FOR THE AHD DER OF THIS SURVEY.	RIVATION
						×	7		
				UTI	LITY SERVICES:	Service Available	Service Not Ava	ailable Availability to be confir	rmed●
CARBOROUGH WA PORCOS) 6144 www.vi	isionsc.com.au <b>isionsc.com.au</b>								×
3ARBOROŬGH WA <b>1900</b> (708) 6144 www.vi 19 0099		JR SUR\	/EY						×
ARBOROŬGH WA 1900(08) 6144 www.vi 19 0099	isionsc.com.au	NOTE: THIS PLAN IS THE	PROPERTY OF VISION	WA				Dever - U/G	×
3ARBOROŬGH WA <b>1900</b> (708) 6144 www.vi 19 0099	isionsc.com.au	NOTE: THIS PLAN IS THE CONSULUTING AND ITS C REFRODUCED WITHOUT	PROPERTY OF VISION IENT. THIS SHORWIRVING THE PERMISSION OF BOTH					POWER - U/G -C VS010238 JOB NUMBER DRAFTED BY: CM CHECKED BY: DS	
GARBOROŬGH WA 1900(208) 6144 www.vi 019 0099	isionsc.com.au	NOTE: THIS PLAN IS THE CONSULIDITING AND ITS C REFIREDUCED WITHOUT PARTIES. ALL DISCLAIMERS SHOV	PROPERTY OF VISION LENT. THIS SHOULDWENTS THE PERMISSION OF BOTH IN ON THIS PLAN ARE TO BE	CLIENT:		GAS 1	 TELSTRA/NBN	POWER - U/G -C VS010238 JOB NUMBER DRAFTED BY: CM CHECKED BY: DS DRAFTING DATE: 16.10.2024	
GARBOROŬGH WA PGAQOS) 6144 WWWW.VI 0099 FEATU	isionsc.com.au	NOTE: THIS PLAN IS THE CONSULIDITING AND ITS C REFIREDUCED WITHOUT PARTIES. ALL DISCLAIMERS SHOV	PROPERTY OF VISION IENT. THIS SHORWIRVING THE PERMISSION OF BOTH	CLIENT: ADDRESS: 23 D	TER SEWER		 TELSTRA/NBN	POWER - U/G -C VS010238 JOB NUMBER DRAFTED BY: CM CHECKED BY: DS	
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CARBOROŬGH WA FØ&@08) 6144 www.vi 019 0099	isionsc.com.au	NOTE: THIS PLAN IS THE CONSULTING AND ITS C REMICOLUCED WITHOUT PARTIES, ALL DISCLAIMERS SHOV BEADUNCTION WITH VIS XURMS	PROPERTY OF VISION LENT. THIS SHOULDWENTS THE PERMISSION OF BOTH IN ON THIS PLAN ARE TO BE	CLIENT: ADDRESS: 23 D	TER SEWER		 TELSTRA/NBN	POWER - U/G -C VS010238 JOB NUMBER DRAFTED BY: CM CHECKED BY: DS DRAFTING DATE: 16.10.2024 SURVEY DATE: 03.10.2024 DWG REF: Dane 23 - FEATUR	





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#### TOWN OF VICTORIA PARK **GENERAL NOTES:** Received: 16/10/2024 THE HOME OWNER IS SOLELY RESPONSIBLE FOR THE DESIGN AND CONSTRUCTION OF ALL FUTURE WORKS AN DANY EFFECT IT SHALL HAVE ON THE EXISTING STRUCTURE. ALL DIMENSIONS SHOWN ON FLOOR PLAN ARE NOMINAL DIMENSIONS ONLY NUMBER OF DESIGN OF DE ALL DIMENSIONS SHOWN ON FLOOR PLAN ARE NOMINAL DIMENSIONS ONLY WHICH DO NOT ALLOW FOR PLASTER THICKNESS OR CORNER BEADING. PLANS TO BE READ IN CONJUNCTION WITH ENGINEERS DETAILS. FLOOR WASTE, CEILING VENT & MANHOLE LOCATIONS ARE SUBJECT TO CHANGE AT THE BUILDER'S DISCRETION. THE BUILDER RESERVES THE RIGHT TO ADJUST WINDOW AND SLIDING DOOR SIZES, INTERNAL ROOM SIZES, AND O'ALL LENGTH AND WIDTH OF DWELLING, WHICH MAY RESULT IN A CHANGE IN THE O'ALL HOUSE AREA FROM THE ORIGINAL STANDARD HOUSE PLAN. DO NOT SCALE FROM THIS DRAWING, ALL SUB-CONTRACTORS TO CHECK DIMENSIONS AND NOTES PRIOR TO INITIATING WORKS. ANY DISCREPANCIES TO BE NOTIFIED TO THE SITE SUPERVISOR WITHOUT DELAY. THESE DRAWINGS ARE TO BE READ IN CONJUNCTION WITH THE STRUCTURAL ENGINEER'S DRAWINGS 7780 2000 5780 2790 2530 230 230 2700 90 830 230 1470 230 2530 1690 90 920 230 230 1450 850 1170 1570 1<u>0</u>0 770 1540 330 2020 **BRICKLAYER NOTES:** 230w CAVITY BRICKWORK, THIRD BOND & RENDER FINISH EXTERNALLY AS SHOWN ON FLOOR PLAN & ELEVATIONS. WEEPHOLES AT MINIMUM 1200 CENTRES TO CAVITY BRICKWORK AD06, PATIO · 2ND FACE BRICKWORK TO INSIDE OF GARAGE FL 9.91 ™ **€0**04 PLASTERER/ RENDERER NOTES: E3 ACRYLIC RENDER EXTERNALLY ACRYLIC RENDER EXTERNALLY INSTALL METAL ANGLE BEADS TO ALL WALL CORNERS INSTALL PLASTIC BEAD TO FRONT ENTRY DOOR SILL WHEN RENDERED DO NOT COVER WEEP HOLES WITH RENDER 2143H x 1450W 1029H x 850W RENDER TO EXTEND DOWN TO BOTTOM OF FOOTING 720 1810 **CONCRETOR NOTES:** 2550 BATH PIER & POST FOOTING TOP @ -2c FROM PAVING LEVEL OR AS NOTED ON FLOOR PLAN 3480 PATIO BED 4 RAKED 4230 FL 10.00 FL 9.91 23 BIR 720 GARAGE GRANO NOTES: 8 • INSTALL EXPANSION FOAM IN BETWEEN GRANO AND BRICKWORK TO INSIDE PERIMETER OF GARAGE LIN 1690W 1690 3690 **ROOF PLUMBER NOTES:** BED 3 514H x 1 3090 FL 1 00 2143H x1570W SD • DOWNPIPES TO BE LOCATED AS PER PLANS BUT MAY BE RELOCATED AT SUPERVISORS DISCRETION. L'DRY 1570 GUTTER BRACKETS TO BE INSTALLED @ 1200mm MAX CENTRES **ROOF CARPENTER NOTES:** 1275 610 190 HALLWAY \*\* CONVENTIONAL TIMBER FRAMED ROOF APPLIES IN PDR ACCORDANCE TO AS1684. • ROOF FRAMING TO BE MINIMUM H2 TREATED TIMBER. • ROOF BEAMS ARE SHOWN DIAGRAMMATICALLY ONLY 2143H x1570W SD × 970W $\odot$ 970 1760 1760 ENS-2 ¢ 1029H REFER TO ENGINEERS DETAIL. **CEILING FIXER NOTES: \*8 \*8** • CEILING @ 31c TO GROUND FLOOR UNLESS NOTED OTHERWISE. LIVING N.C.C NOTES: 4825 8 ALL BALUSTRADE & HANDRAILS AS PER N.C.C (BCA VOL 2) CLAUSE 3.9.2 SMOKE ALARM TO BE HARD WIRED, INTERCONNECTED AS PER N.C.C x 241 2410 3500 3500 (BCA VOL 2) CLAUSE 3.7.2 AND AS 3786 NEW FIXED SKYLIGHT 514H ; BED 2 WINDOW 550Wx1400H 20490 **PLUMBER NOTES:** • REFLUX VALVE TO SEWER 780 \$\$ **GLAZING NOTES:** 750H x 1400W • ALL GLAZING IN ACCORDANCE WITH BCA CLAUSE 1400 3.6 AND AS1288 @25c x 3130W RAI NEW FIXED SKYLIGHT **TERMITE TREATMENT** STRUCTUR BRICK BEAM 3130 3270 3270 WINDOW 550Wx1400H DINING 514H x ЭФ KITCHEN NOTES: ¢¢ ALL PRIMARY BUILDING ELEMENTS ARE TERMITE RESISTANT. • TERMITE TREATMENT TO BE COMPLIED AS PER BCA CLAUSE 3.1.4 AND AS3660.1 INC. BOUNDARY TREATMENT. 2930 1270 000 820

1280

S2 AD06

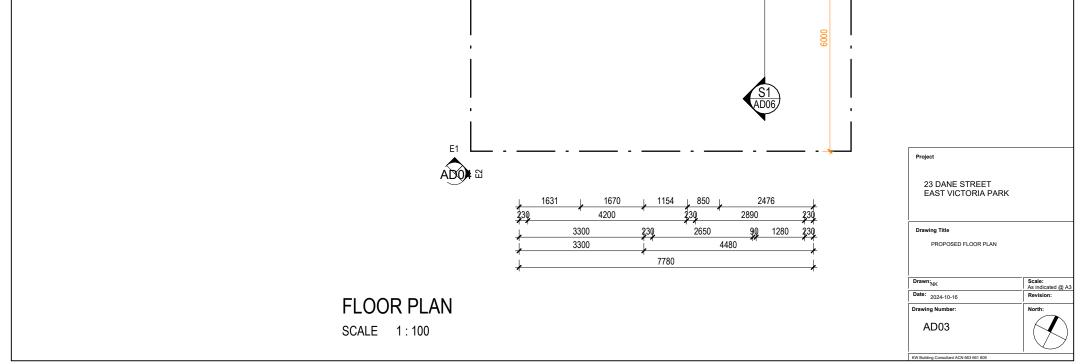
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## WATERPROOFING NOTES:

5765

1900

- WATERPROOFING MEMBRANES FOR EXTERNAL ABOVE
- GROUND TO COMPLY WITH AS4654.1 AND AS4654.2. WATERPROOFING TO WET AREAS TO COMPLY WITH BCA CALUSE 3.8.1 AND AS3740.



LOUNGE

/FL 10.00

920

514H × 2050M

BED CL 240 FL 10.0

720

WIR

ENS-1

CL 2400 FL 10.00

1029H x 850V

2050 3510 3510

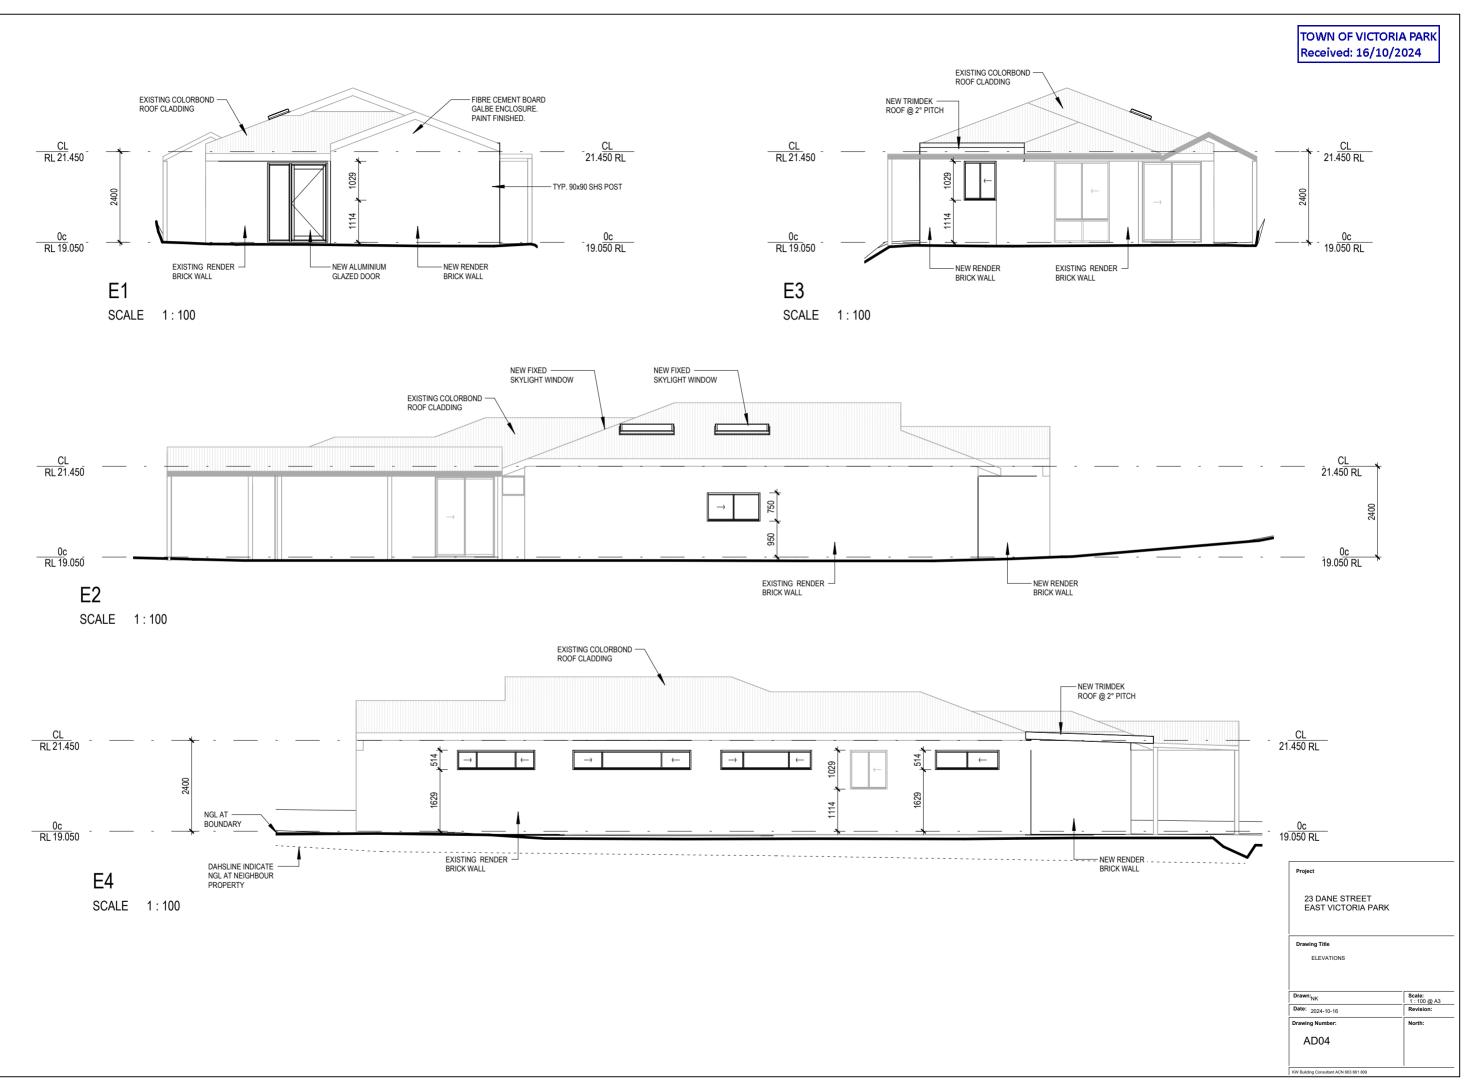
8

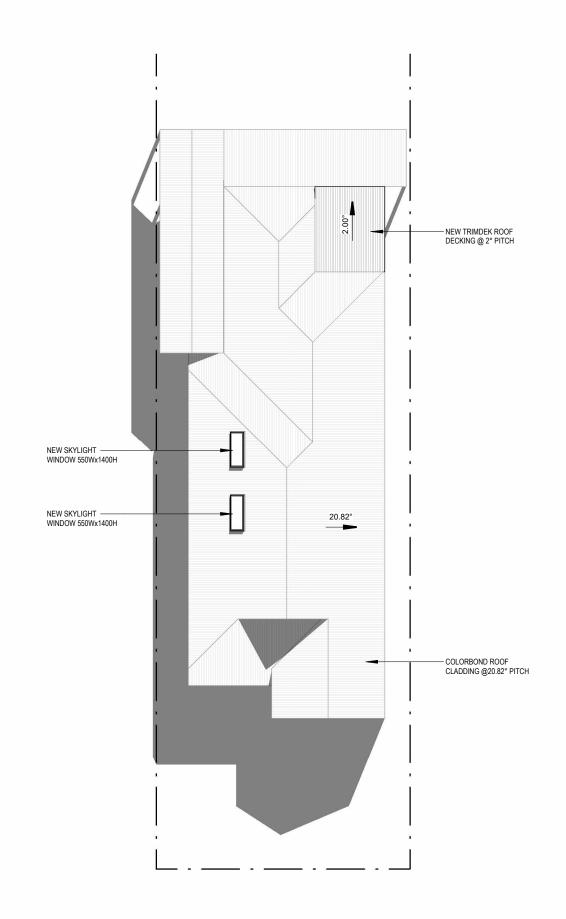
1760 1670

2680

AD06

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## ROOF PLAN SCALE 1:150

